



notes :

1. If this drawing has been received electronically it is the recipient's responsibility to print the document to the correct scale.
2. All dimensions are in millimetres unless stated otherwise. It is recommended that information is not scaled off this drawing.
3. This drawing should be read in conjunction with all other relevant drawings and specifications.


Note:  
Cooling Tower plans and elevations based on IESI Ltd drawing E-ROSE-1008 (Oct 06)  
All Elevations and Dimensions subject to final design

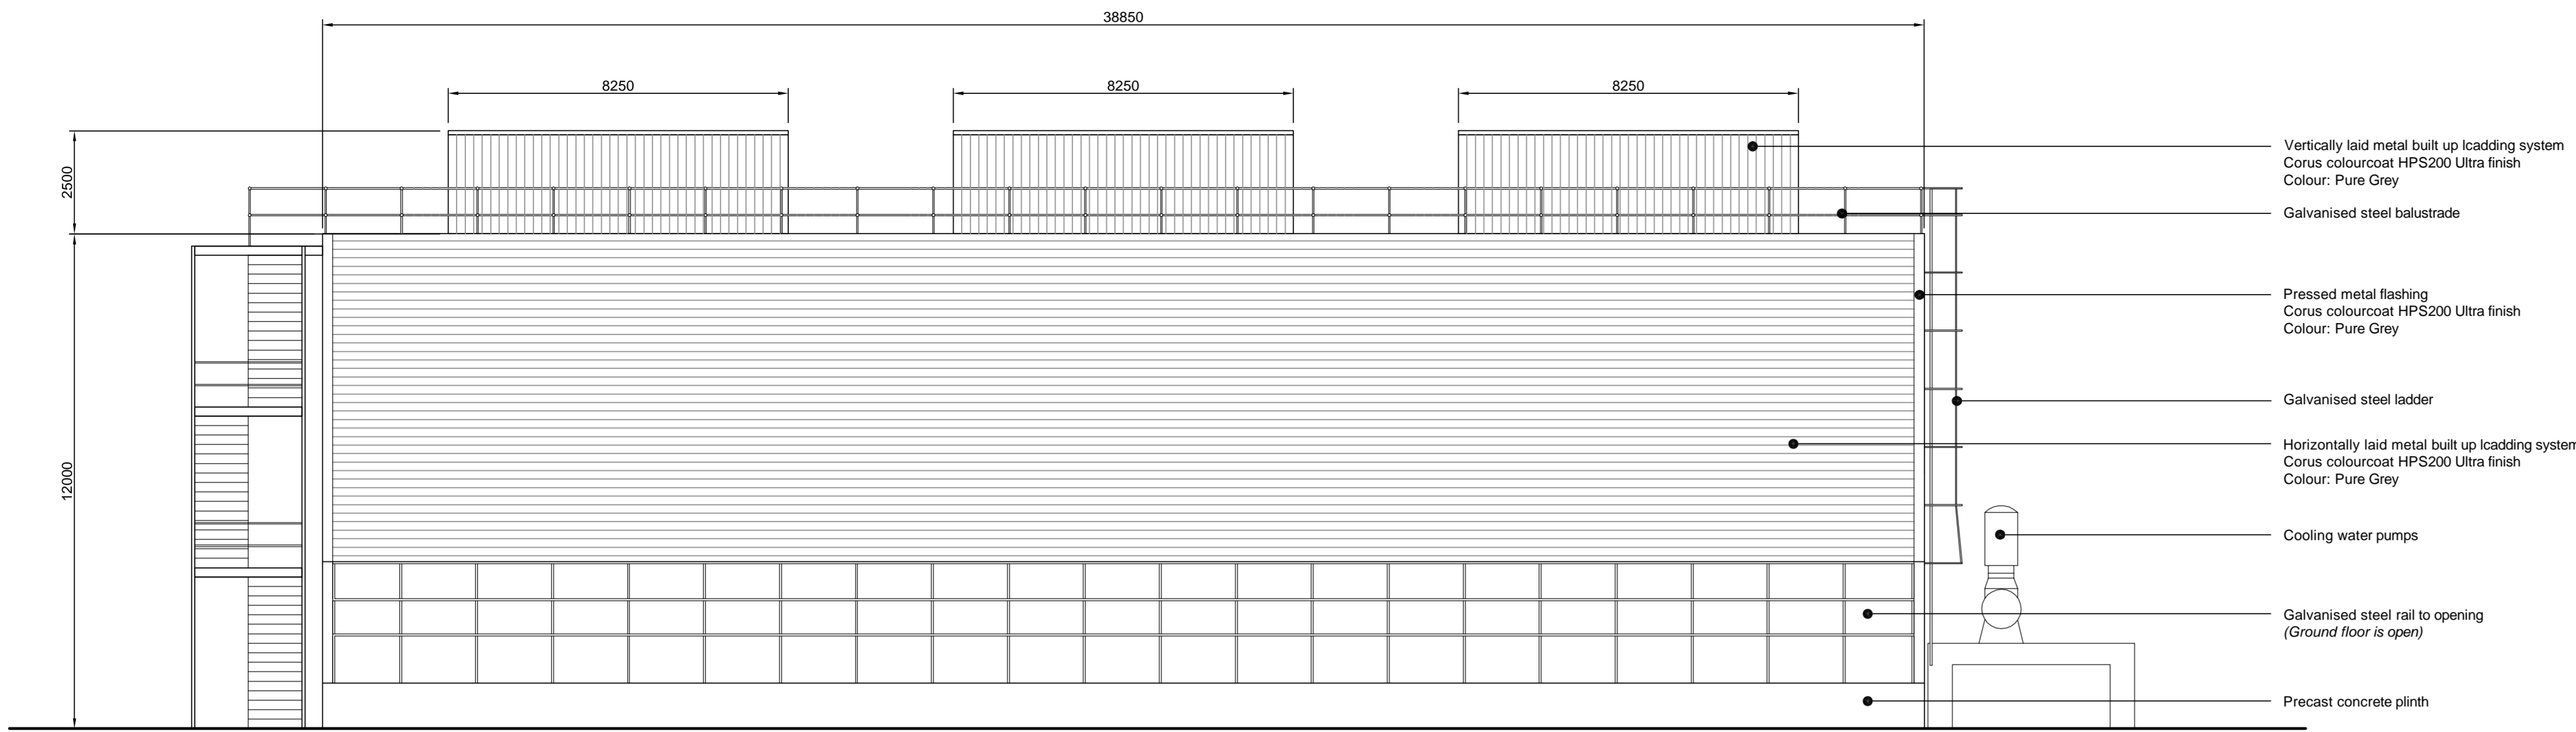


North Elevation  
Scale 1:100

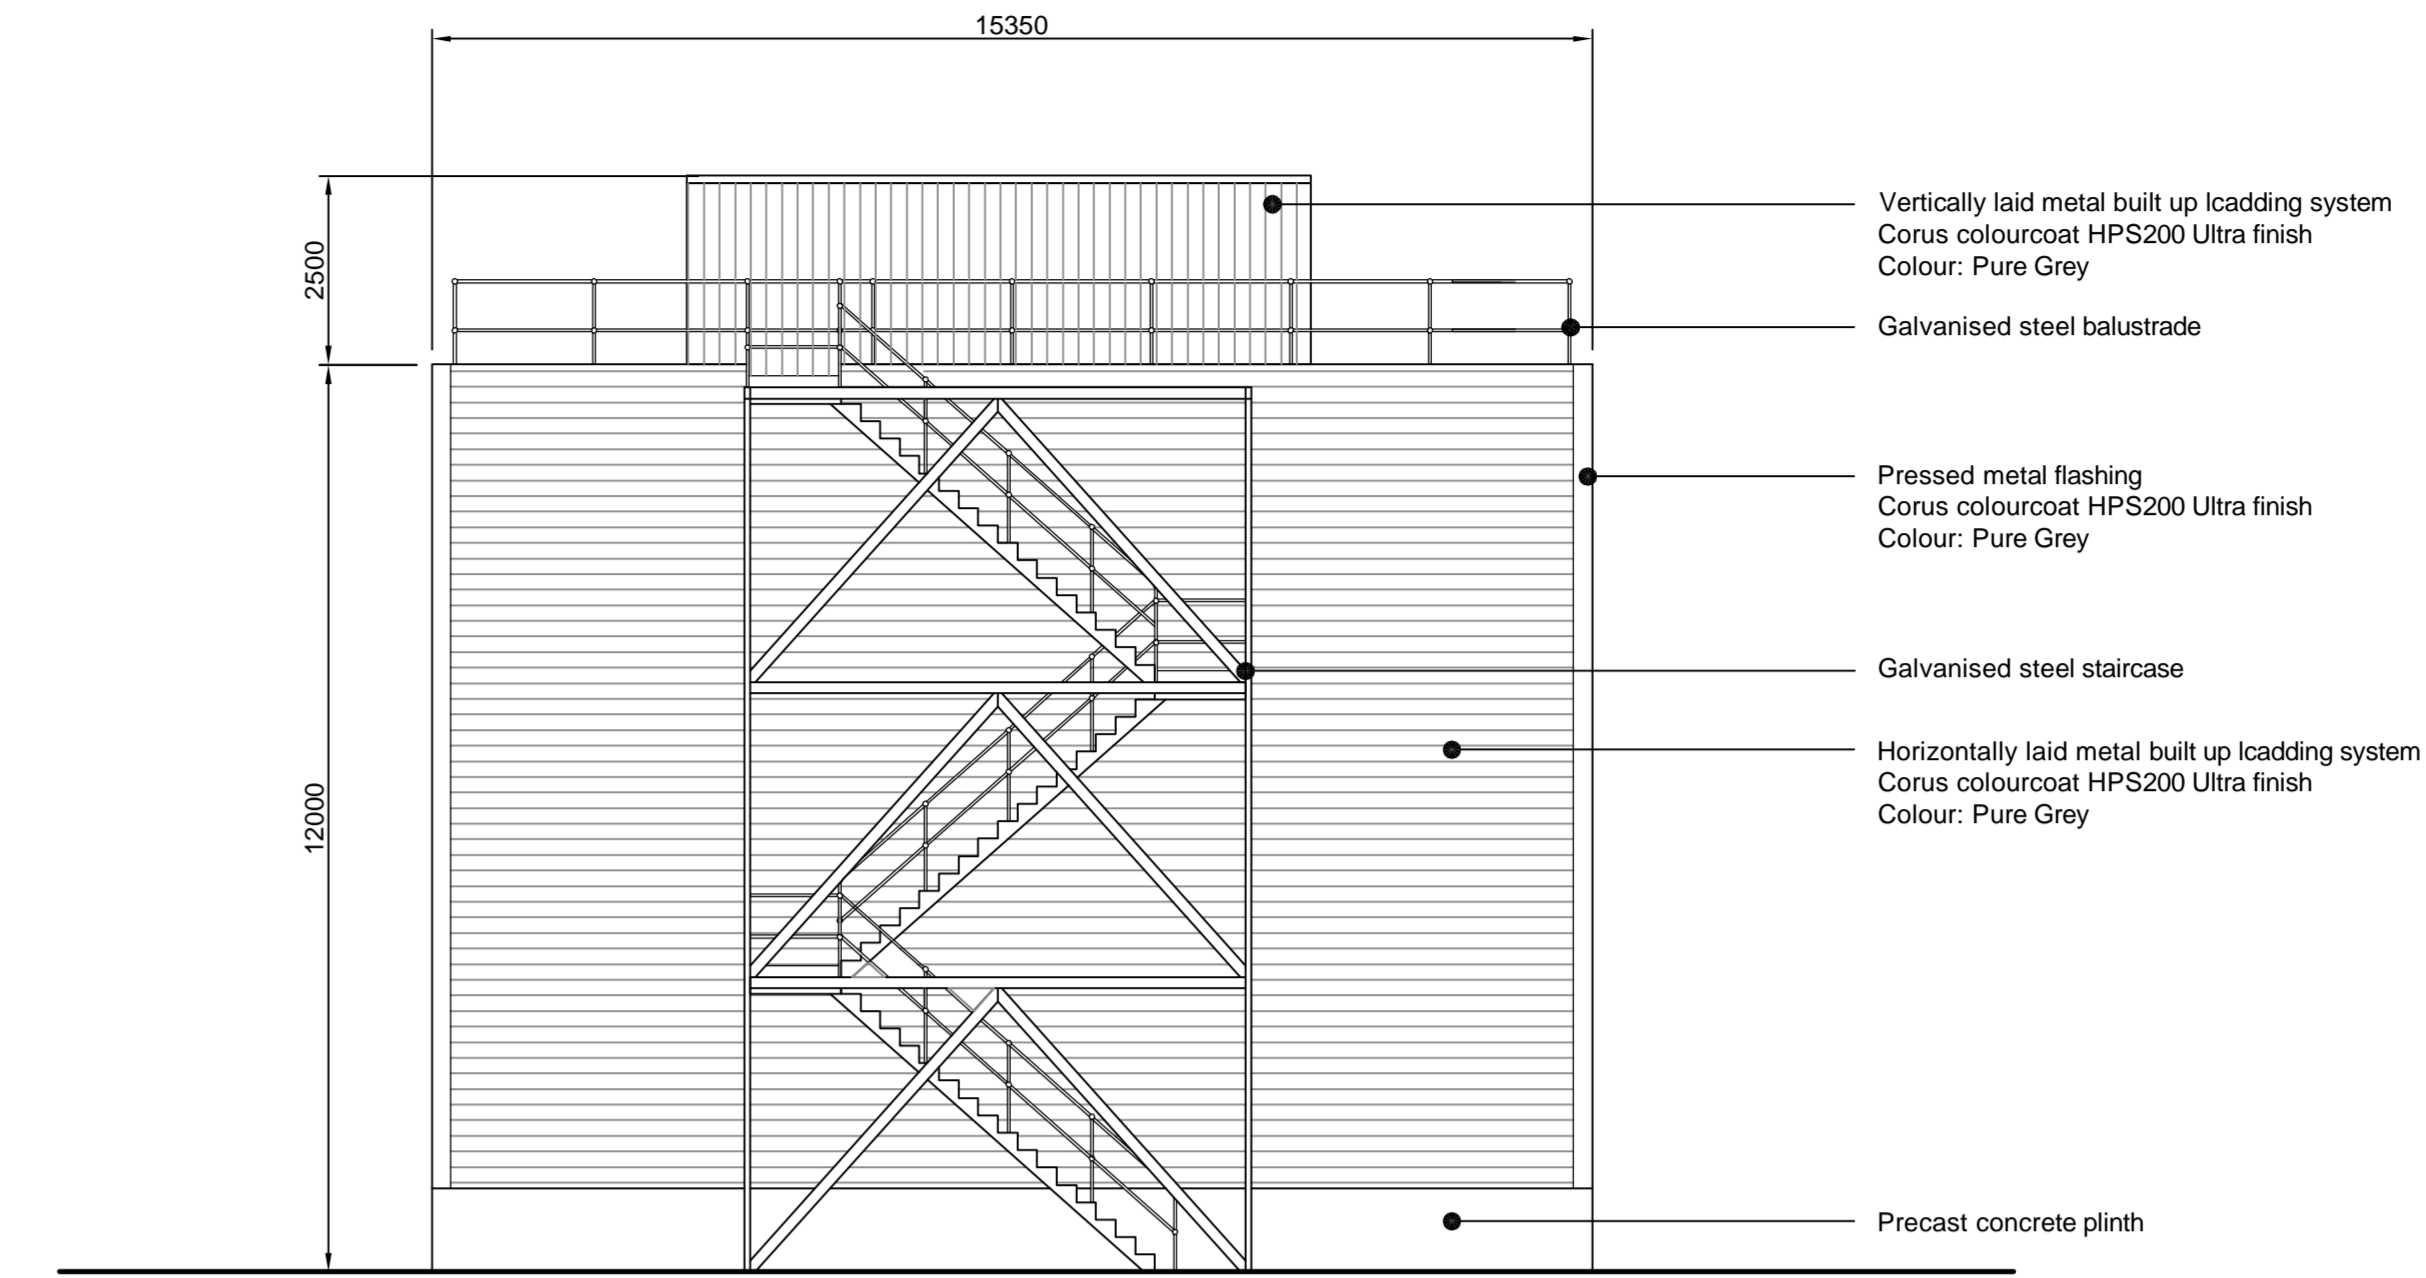


East Elevation  
Scale 1:100

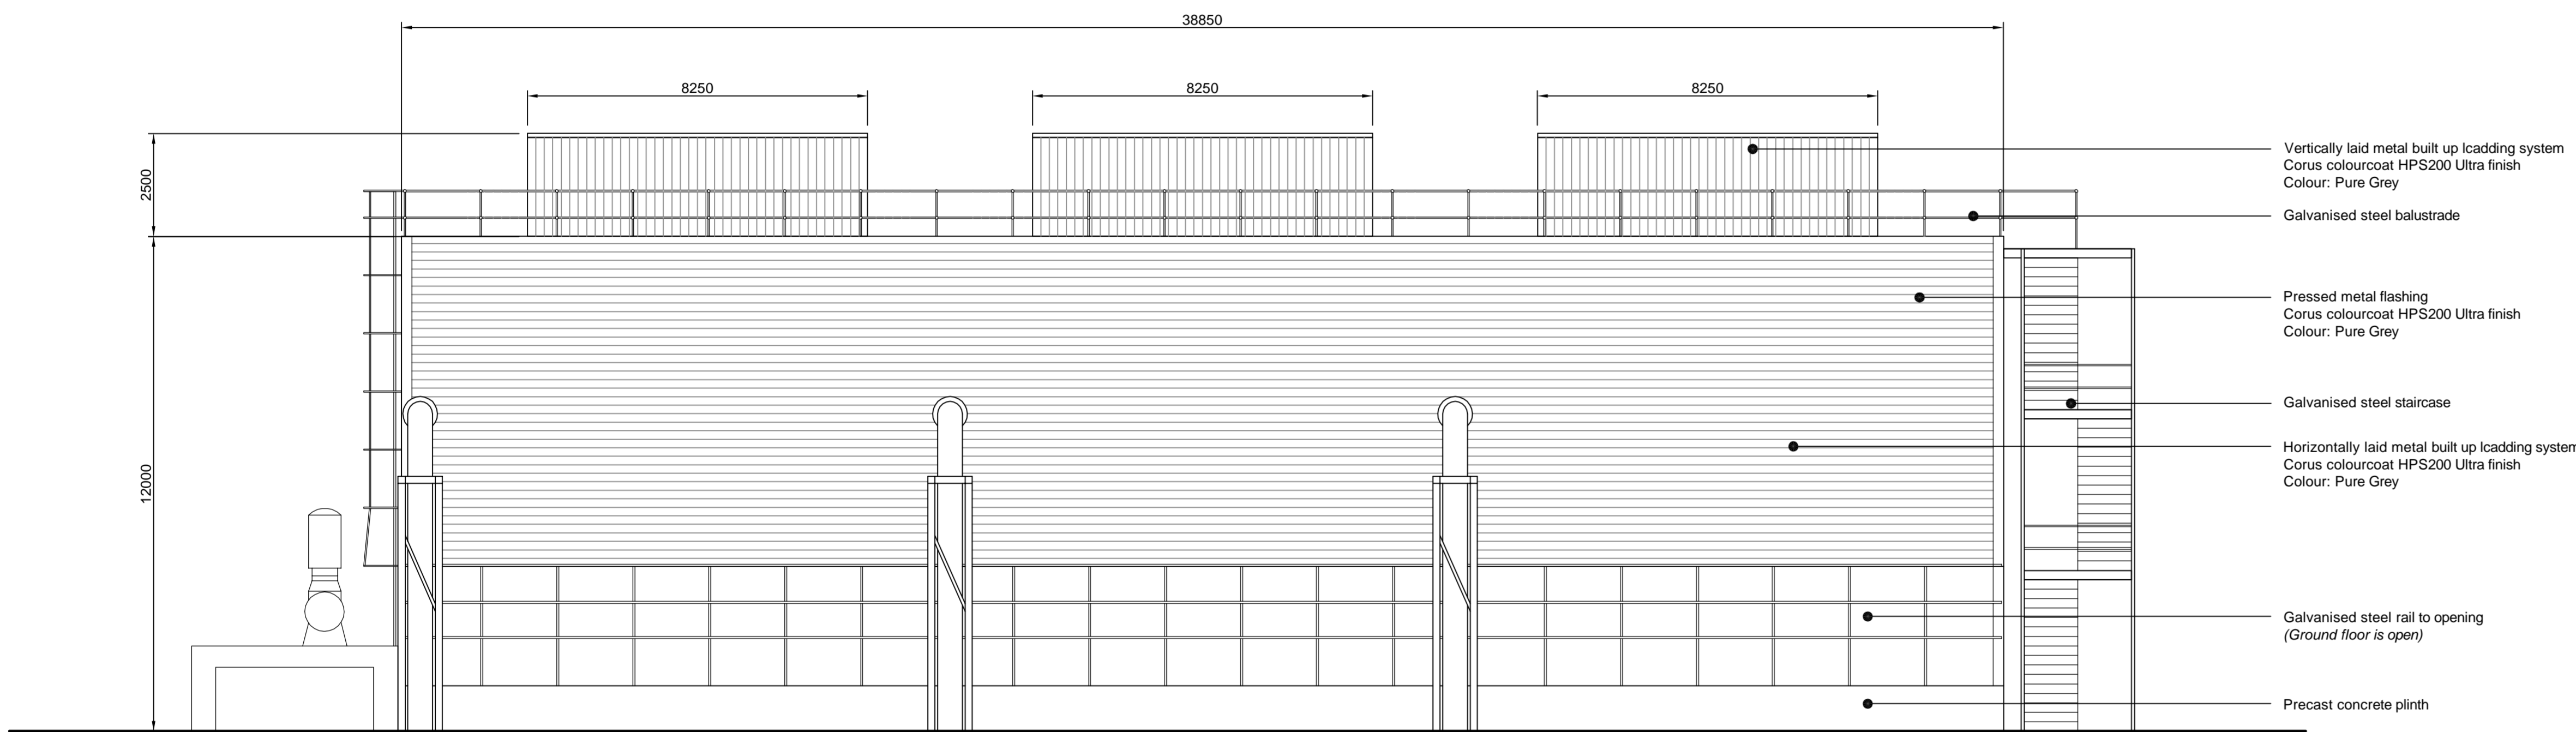

South Elevation  
Scale 1:100

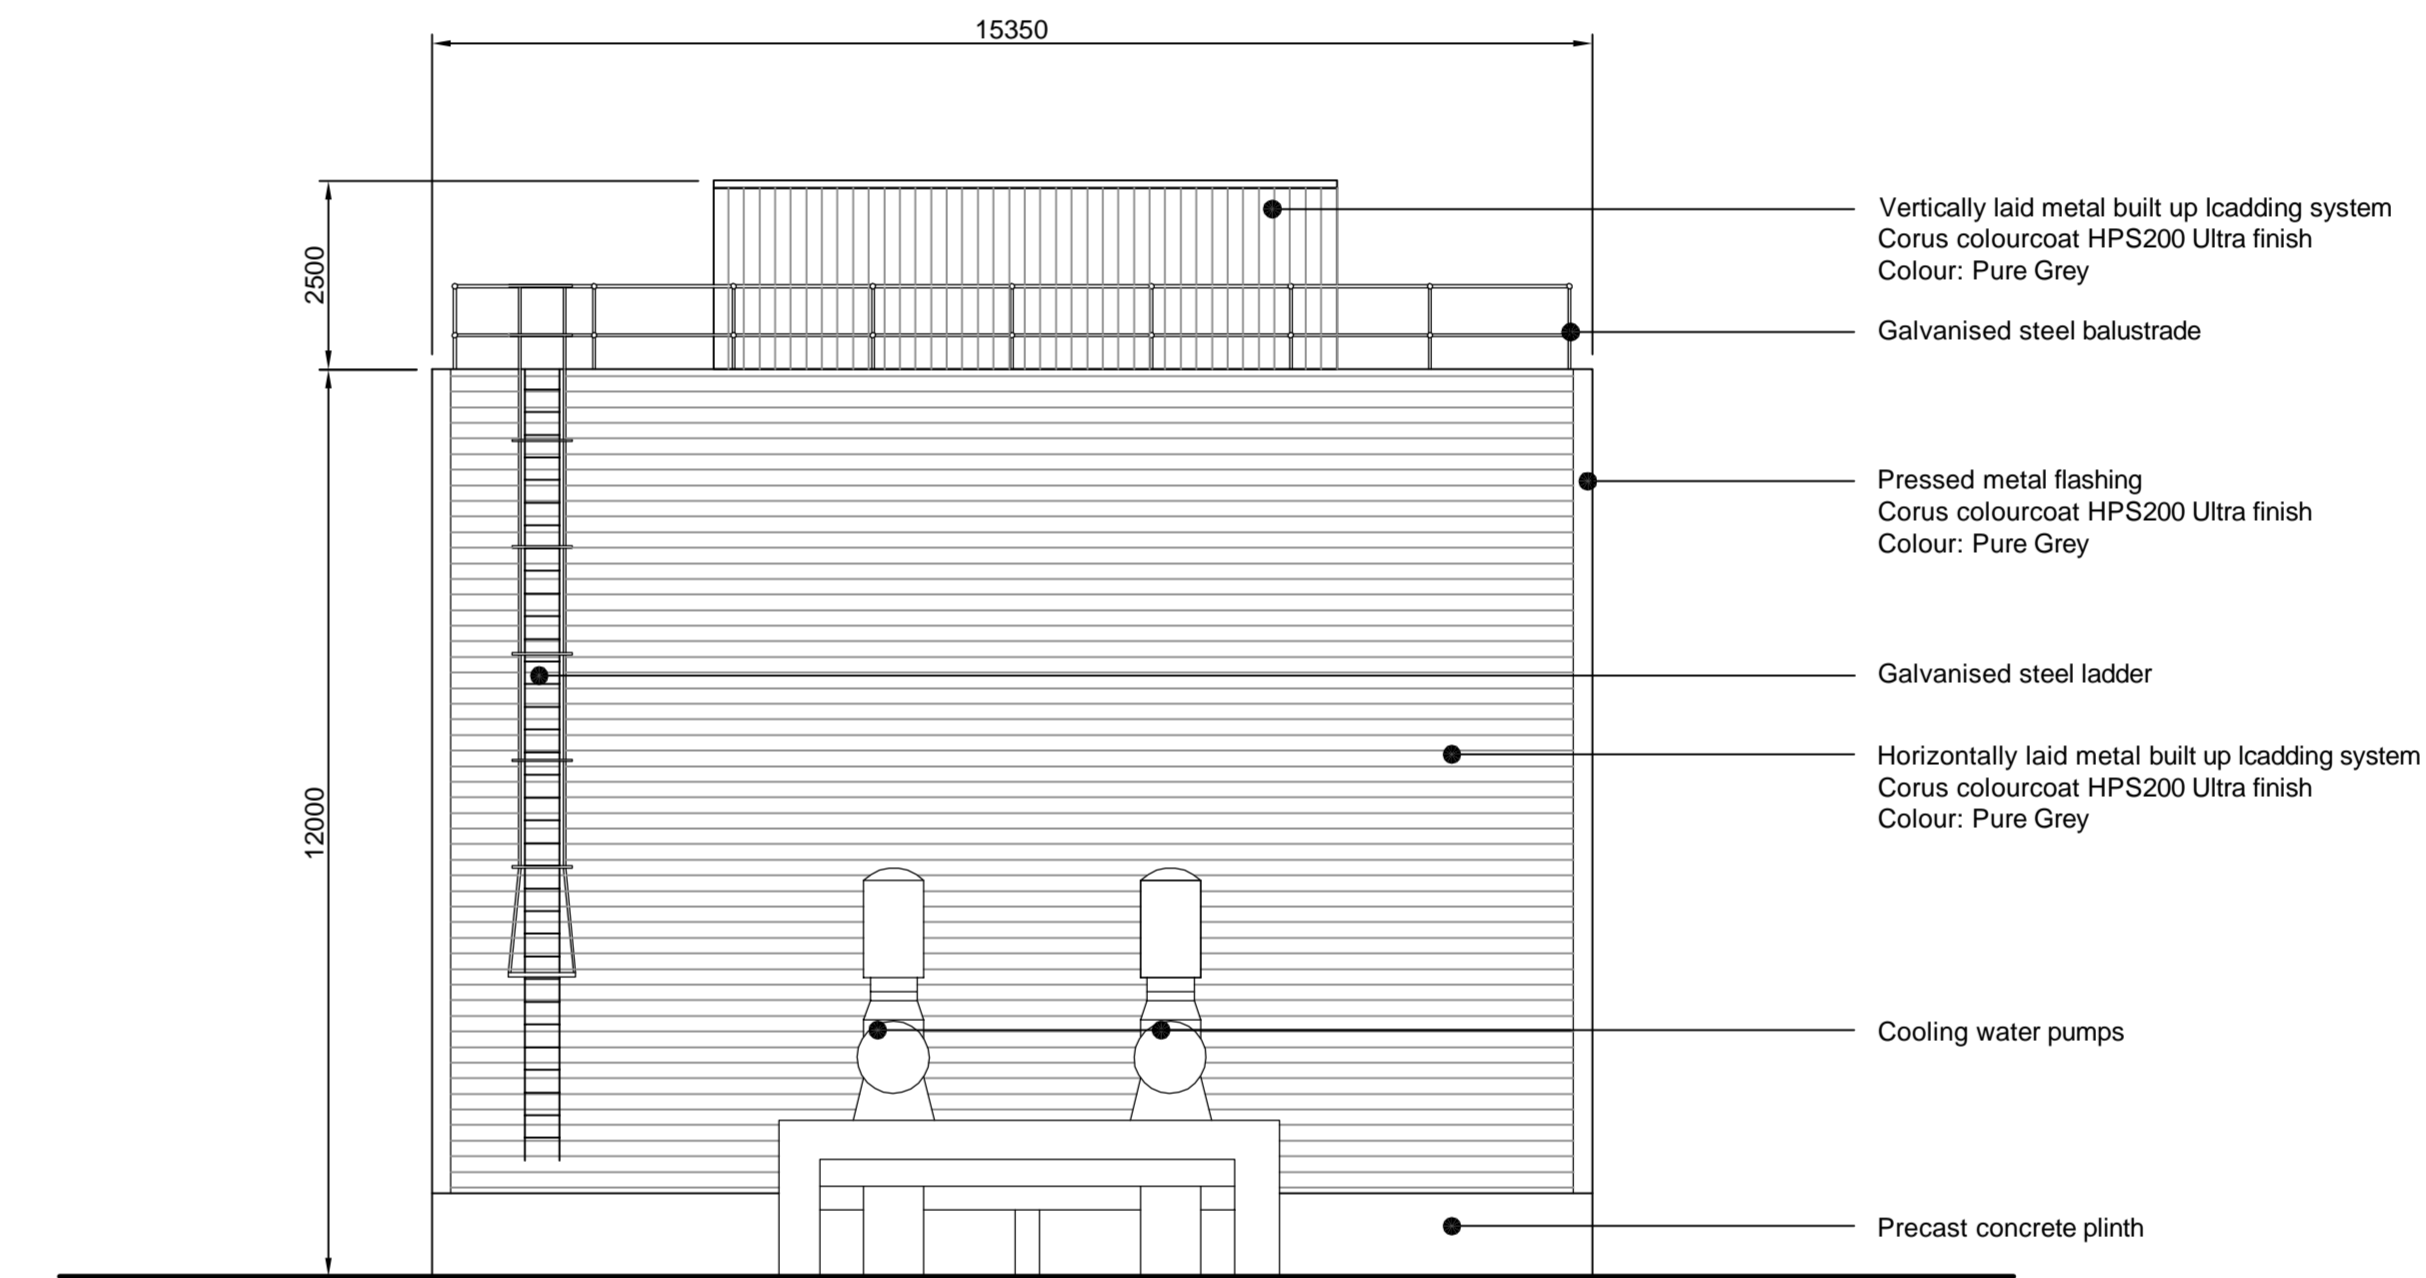

West Elevation  
Scale 1:100

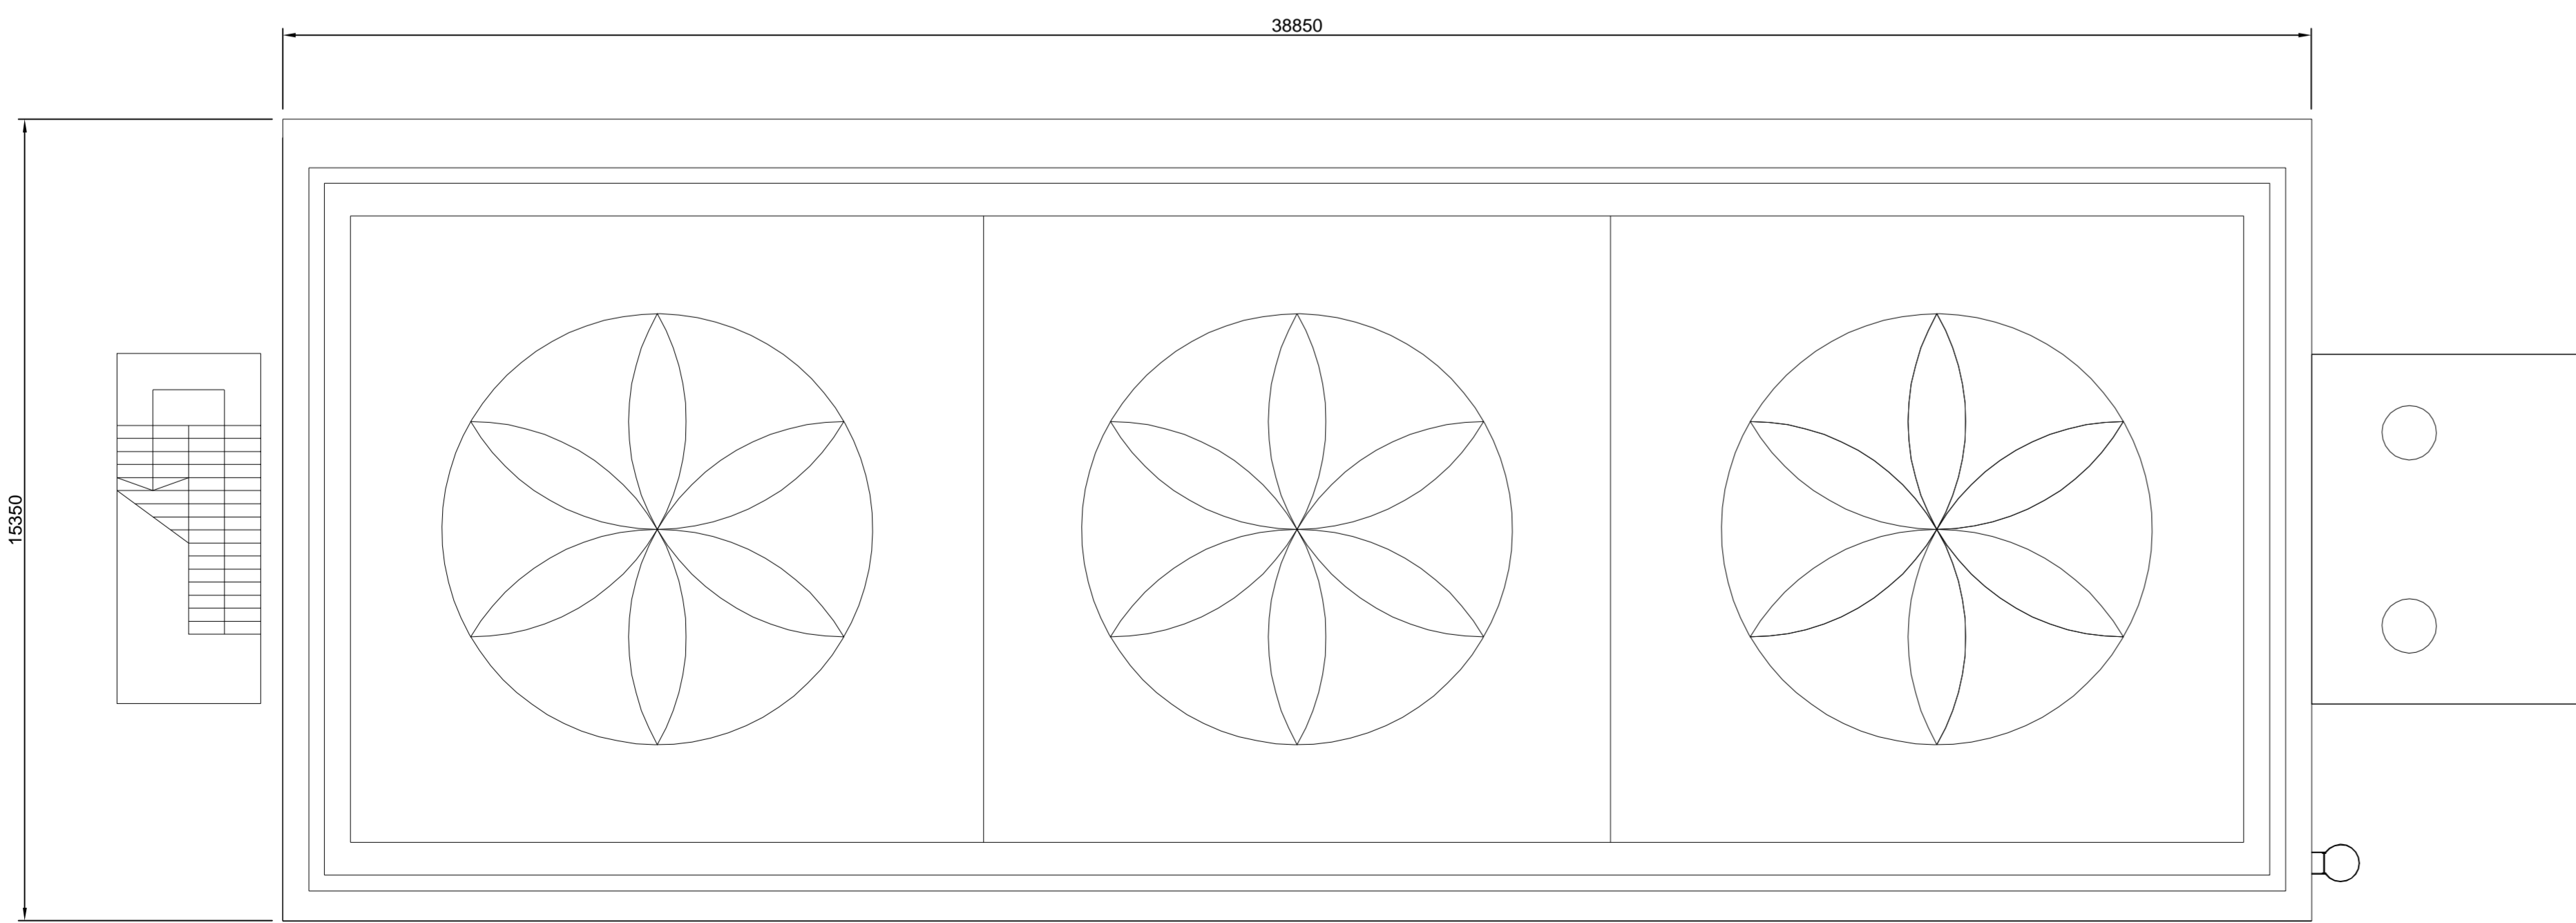

Plan  
(Plant Indicative)  
Scale 1:100

**For Planning Purposes**

		T +44 (0) 1636 655 700 F +44 (0) 1636 655 690 www.rpsgroup.com e rps@rps.com
<b>Client</b> Rose Energy Facility Glenavy		
<b>Title</b> Cooling Tower Plan & Elevations		
<b>Drawing Status</b> Preliminary	<b>Date Created</b> April 2008	<b>Drawing Scale</b> 1:100
<b>Project Leader</b> AWY	<b>Drawn By</b> IRD	<b>Initial Review</b> RS
<b>Drawing Number</b> 15562 / A0 / 118		<b>Rev</b> -

